

# NATIONAL SENIOR CERTIFICATE

**GRADE 12** 



**DEAF LEARNERS** 

**ENGINEERING GRAPHICS AND DESIGN P1** 

**SEPTEMBER 2023** 

PREPARATORY EXAMINATION

**MARKS: 100** 

TIME: 3 hours

This question paper consists of 6 pages.

Copyright reserved

# **INSTRUCTIONS AND INFORMATION**

- 1. The question paper consists of FOUR questions.
- 2. Answer ALL the questions.
- 3. All drawings must be drawn to scale 1 : 1, unless otherwise stated.
- 4. ALL drawings are in first angle orthographic projection, unless stated otherwise.
- 5. ALL drawings must be prepared using pencil and instruments, unless otherwise stated.
- 6. ALL answers must be drawn accurately and neatly.
- 7. ALL the questions must be answered on the question paper, as instructed.
- 8. All the answer sheets must be re-stapled in numerical sequence and handed in irrespective of whether the question was attempted or not.
- 9. Time management is essential in order to complete all the questions.
- 10. Print your name in the block provided on every ANSWER SHEET.
- 11. Any details or dimensions not given, must be assumed in good proportion.

FOR OFFICIAL USE ONLY							
	MODERATED MARK						- 1
1							
2							
3							
4							
TOTAL							
	2	0	0		2	0	0

FINAL CONVERTED MARK	CHECKED BY
100	


COMPLETE THE FOLLOWING:
NAME
NAME
EXAMINATION CENTRE
EXAMINATION CENTRE

Please turn over

NSC Engineering graphics and design / P1 EC / September 2023

	SYMBOL LEGEND							
1		BRICK PAVING						
2	-00-	2 100 mm HIGH PALISADE FENCING						
3	<del>-× × ×</del>	1 800 mm HIGH SECURITY FENCING						
4		1 800 mm HIGH BRICK WALL						
5		INDIGENOUS TREE						
6	6.5	SHRUBS						

LAND SURVEY	OR'S CERTIFICATE					
OF THE BORDER LINE LENGTHS						
AND CORN	ER HEIGHTS OF					
STA	AND 1144					
SURVEYED	O ON 2023-01-08					
LENGTHS IN CORNER HEIGHTS IN						
MILLIMETRES METRES						
AB = 36 400 A = 1 550						
BC = 36 400	B = 1 552					
CD = 5 600						
DE = 32 400 D = 1 552						
AE = 40 400	E = 1 550					

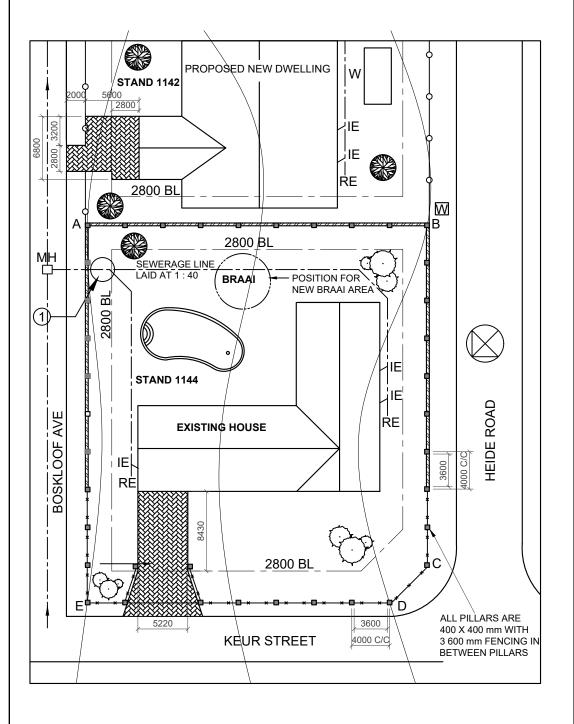

## NOTE:

Contractors must verify all dimensions and levels on the site before commencing work. Architects to be notified immediately of any discrepancies.

ARCHITECT'S SIGNATURE	
CLIENT'S SIGNATURE	

### **ANSWER 17**

DUESTION 1:	<b>ANALYTICAL</b>	(CIVIL)
XOEO11011 1.	AIIAE I IIVAE	( O I V I L /

### Given:

The site plan of an existing house with alterations and section of a new dwelling on the adjacent stand, a title block and a table of questions. The drawing has not been prepared to the indicated scale.

### Instructions:

Complete the table below by neatly answering the questions which refer to the accompanying drawing and title block. [29]

ARCHITECT'S SIGNATURE		Complete the table below by neatly answering the questions which refer to the accompanying drawing and title block. [29]							
CLIENT'S SIGNA	TURE			QUEST	TIONS		ANSWERS	<b>;</b>	
	ANSWEF	2 17	1	Who was responsible for checking	ng the correctness of the drawing?			1	
freehand, t	e below, d	lraw in neat ew and top view	2	Who is the owner of the stand 11	144?			1	
for a BIDE		raphical symbol	3	What is the reference code of this	s drawing?			1	
			4	How far, in meters, are the pillars another on stand 1144?	s of the brick wall spaced from one			1	
			5	When was the second revision de	QUESTIONS  ANSWERS  In the stand 1144?  Inter of the stand 1144 inter of the stand 1144 inter of the stand 1144?  Inter of the stand 1144 inter of the stand 1142. Give a reason of the stand 1142. Give a reason of the stand 1144 inter of the space provided below (ANSWER 15) the total length of the brick wall fencing on the space provided below (ANSWER 16), the total area of the paved ramp on stand of the stand symbol for a bidet.  Inter title panel (ANSWER 17), draw in neat freehand, the top view and front view of the graphical symbol for a bidet.  Inter of the stand 1142 interest of the space provided below (ANSWER 16), the total area of the paved ramp on stand or meters.  Inter of the stand 1142 interest of the paved ramp on stand or meters.  Inter of the stand 1142 interest of the paved ramp on stand or meters.  Inter of the stand 1142 interest of the paved ramp on stand or meters.  Inter of the stand 1142 interest of the paved ramp on stand or meters.  Inter of the stand 1142 interest of the paved ramp on stand or meters.  Inter of the stand 1142 interest of the paved ramp on stand or meters.  Interest of the stand 1142 interest of the paved ramp on stand or meters.  Interest of the stand 1142 interest of the paved ramp on stand or meters.  Interest of the stand 1142 interest of the paved ramp on stand or meters.  Interest of the stand 1142 interest or the stand 1142 intere				
			6	How many indigenous trees are	on stand 1144?			1	
			7	Indicate the direction of flow <b>on</b> to	he sewerage line with an arrow in t	he circle num	bered 1.	1	
			8	What type of fence does the own the street sides, to secure his ho				1	
			9	In what colour should new alterations be indicated on the site plan?				1	
			10	What is the minimum distance that the braai could be erected in, from the brick wall?			1		
3			11	How many roding eyes are instal	led on stand 1144 ?			1	
2	2023-03-01	Show the position of the Watt meter	12	What is the height of the wall between the two stands, in meters?				2	
1	2023-02-24	Indicate the position of the new braai area	13	The municipality rejected the plans of stand 1142. Give a reason for the decision.				2	
REVISION	DATE	DESCRIPTION ARCHITECTS	14	With reference to the north point, stand 1142?	, on which side is the entrance of			2	
	13 MAIN I	RHA			below (ANSWER 15) the total len	gth of the bri	ck wall fencing on	4	
aspanç	082 346 g.architect	6373 t@gmail.com	16	Determine in the space provided below (ANSWER 16) the total area of the paved ramp on stand			4		
PRINTED BY:  FLEMMING I	PRINTERS	DATE OF PRINT: 2023-02-14	17	In the space at the title panel (ANSWER 17), draw in neat freehand, the top view and front view of the SANS 10143 graphical symbol for a <b>bidet</b> .			4		
DRAWING TITLE	DRAWING TITLE: SITE PLAN			ΙΟΙΔΙ		TOTAL	29		
PROJECT: ALTERATIONS ON STAND 1144 FOR MR ROTHERHAM Cnr. BOSKLOOF AVE & KEUR STREET, HUMANSDORP			Show ALL calculations.	2000, 5600	S.				
PROJECT NUMBER:   DRAWING NUMBER:   LOUK01-2023   DATE:   DRAWN:   CHECKED:   SCALE:			-						
2023-01-06 (	GERHARD	LEAH 1:300	-				NAME		
SITE- 1		1 of 6			ч ч		NAME		2

### **QUESTION 2: INTERPENETRATION AND DEVELOPMENT:** Given:


- The incomplete front view and top view of a square pipe penetrating a pentagonal pipe.
- The center of both pipes are in line with each other.
- Starting point X.

### Instructions:

Draw to scale 1 : 1, the following views:


- 2.1 The complete top view.2.2 The complete front view that clearly shows the curve of the penetration.
- 2.3 The development of ONLY the two surfaces (A and B) of the pentagonal pipe that clearly shows the curve.
- Show ALL centre lines and hidden detail.
- Show ALL necessary construction lines.


[38]

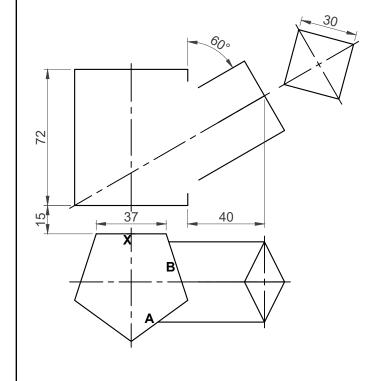

	ASSESSMENT CRITERIA						
1	TOP VIEW	10 ½					
2	FRONT VIEW	17					
3	DEVELOPMENT	10 ½					
PE	PENALTIES (-)						
	TOTAL	38					

NAME	
NAME	3

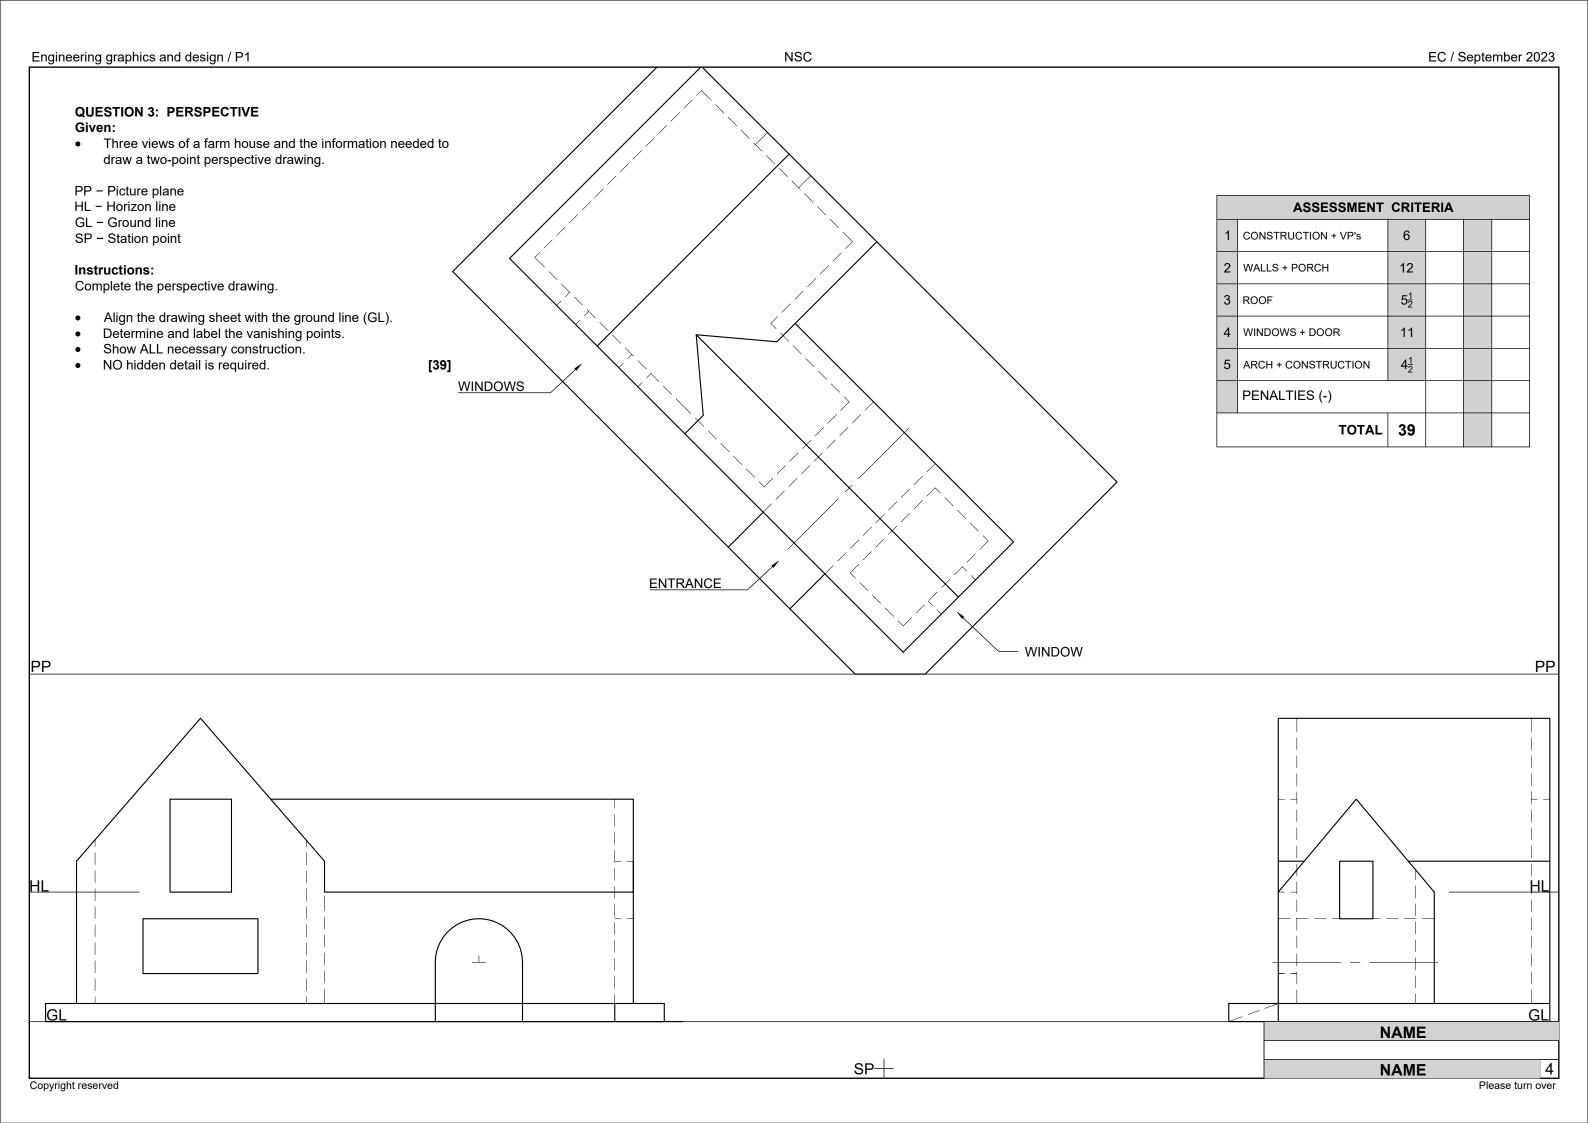

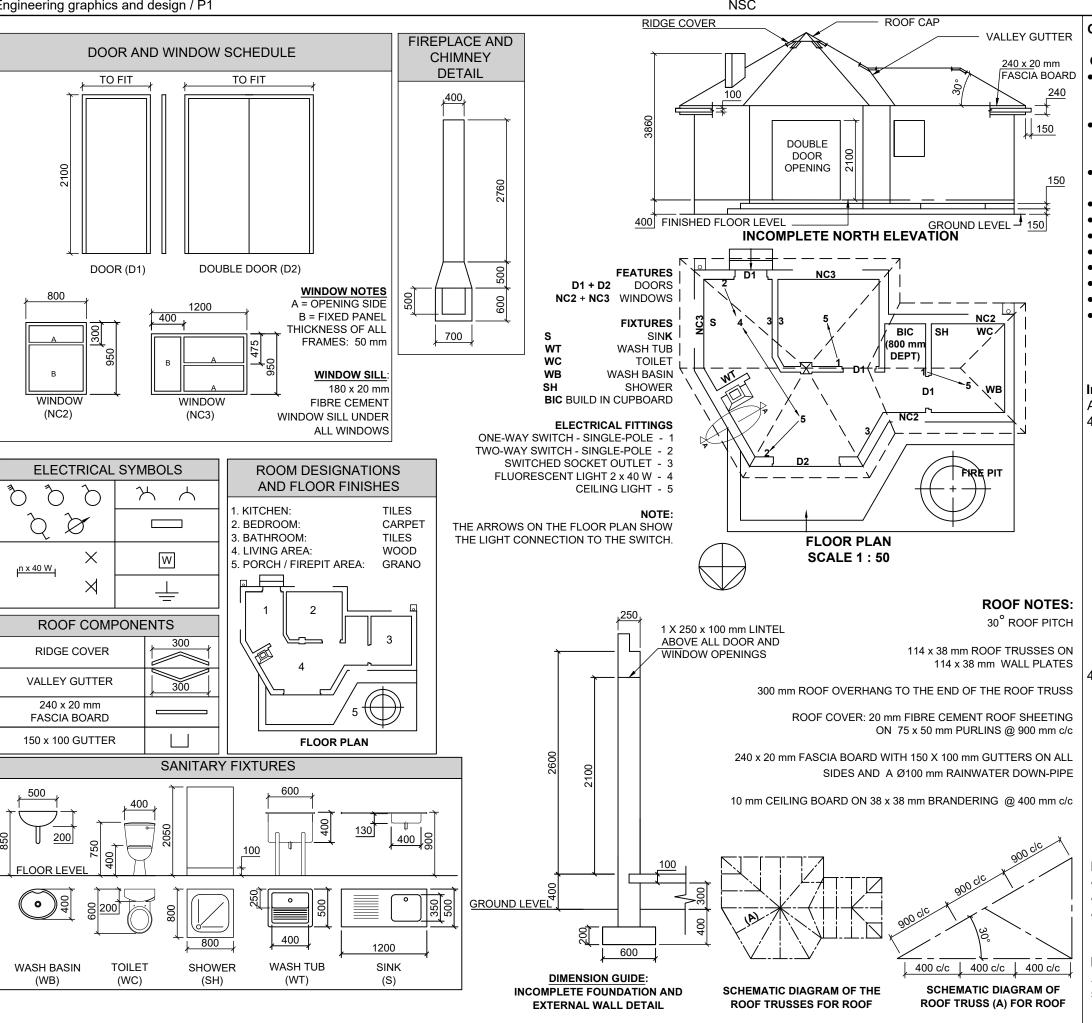

### **QUESTION 4: CIVIL DRAWING**

- The incomplete north elevation of a **new house**, showing the walls, windows and door openings, the fire pit, the position of the chimney, the roof and labels.
- The incomplete floor plan showing the walls, steps, fire pit, position of the doors, windows, fixtures and the electrical
- A schematic diagram of the roof trusses, single truss and roof
- The incomplete foundation and external wall with dimensions.
- A door and window schedule.
- A fireplace and chimney detail.
- A table of electrical symbols.
- A table of roof components.
- Room designations as well as floor finishes.
- A table of sanitary fixtures.
- The incomplete floor plan, ground line and roof cap of a **new** house, drawn to scale 1:50, and the incomplete foundation and a break line for the detailed section, drawn to scale 1: 20, on page 6.

### Instructions:

Answer this question on page 6.

4.1 Use the given incomplete floor plan, to draw, in first-angle orthographic projection to scale 1:50, the following views of the new house:

### 4.1.1 THE COMPLETE FLOOR PLAN

### Add the following features to the drawing:

- ALL doors and windows.
- ALL sanitary fixtures as indicated by the abbreviations.
- ALL electrical fittings as indicated by the numbers.
- ALL hatching detail.

### 4.1.2 THE COMPLETE NORTH ELEVATION

### Show the following features on the drawing:

- The outside walls, double door, steps, fire pit and the detailed windows.
- The roof detail, including the fascia boards, ridge covers, gutters and chimney of the fireplace.
- The finished floor level.
- 4.2 Use the given foundation and break line on page 6, draw, to scale 1: 20 a **DETAILED SECTION** on cutting plane A-A of the area in the ellipse shown on the incomplete floor plan.


### Show the following features on the drawing:

- The complete foundation and external wall detail.
- The fireplace, with the chimney, to the southeast side of the cutting plane A-A.
- The roof detail, including the fascia board and gutter.
- ALL hatching detail. ONLY the substructure hatching may be drawn in neat freehand.

### Label the following:

- The north elevation.
- The floor finishes.
- Ground level, finished floor level and damp proof course (use the correct abbreviations and show it on ALL the relevant views).

ALL drawings must comply with the guidelines and graphical symbols as contained in the SANS 10143. [94]

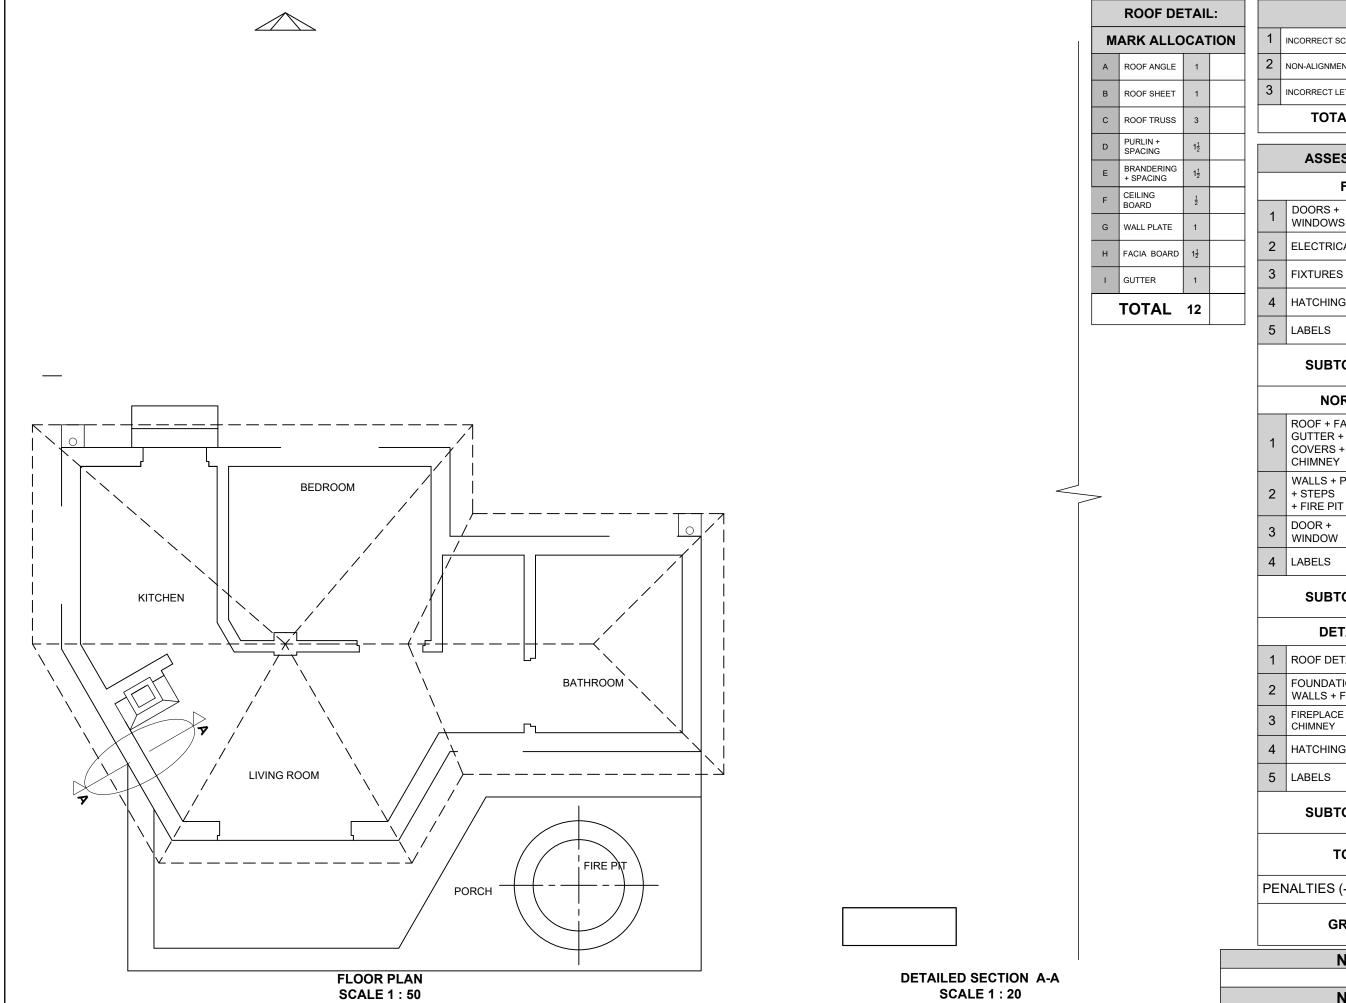

		PENALTIES							
	1	INCORRECT SCALE							
	2	NON-ALIGNMENT OF VIEWS							
	3	INCORRECT LETTERING							
		TOTAL PENALTIES (-)							
$\neg$									

ASSESSMENT CRITERIA								
	FLOOR PLAN							
1	DOORS + WINDOWS	13						
2	ELECTRICAL	8 ½						
3	FIXTURES	10 ½						
4	HATCHING	3						
5	LABELS	2 ½						
	SUBTOTAL	37 ½						
	NORTH EI	EVATI	ON					
ROOF + FACIA + GUTTER + COVERS + CHIMNEY								
2	WALLS + PORCH + STEPS + FIRE PIT + FFL	7						
3	DOOR + WINDOW	6						
4	LABELS	1 ½						
	SUBTOTAL	28 ½						
	DETAILED	SECTI	ON					
1	ROOF DETAIL	12						
2	FOUNDATION + WALLS + FLOOR	5						
3	FIREPLACE + CHIMNEY	6						
4	HATCHING	4						
5	LABELS	1						
	SUBTOTAL	28						
TOTAL 94								
PEN	NALTIES (-)							
GRAND TOTAL								
	NAME							

NAME NAME